DEVELOPMENT APPLICATION

DRAWING SCHEDULE

SITE ANALYSIS PLAN 01
PROPOSED SITE PLAN 02
EXISTING GROUND FLOOR PLAN 03
GROUND FLOOR DEMOLITION PLAN 04
PROPOSED GROUND FLOOR PLAN 05
EXISTING ROOF PLAN 06

ROOF DEMOLITION PLAN 07 PROPOSED ROOF PLAN 08

SOUTH WEST AND SOUTH EAST ELEVATION 09

NORTH AND EAST ELEVATION 10 SECTION VIEW 11

SCHEDULE OF EXTERNAL MATERIALS, COLOURS AND FINISHES 12


IN-GROUND SWIMMING POOL DETAILS 13
DEEP SOIL AREA CALCULATION SHEET 14
GROSS FLOOR AREA CALCULATION SHEET 15

SOLAR STUDY 16 SITE COVERAGE 17

BASIX COMMITMENTS 18

ISSUE DETAILS

A 20.05.24 ISSUED FOR DEVELOPMENT APPLICATION

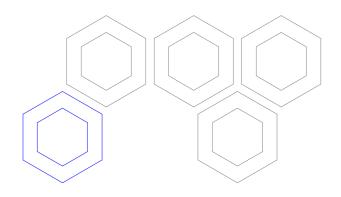



ADDITIONAL INFORMATION

A01 OWNER'S CONSENT FORM

A02 SURVEY PLAN

A03 BASIX & NATHERS CERTIFICATION

A04 STORMWATER PLAN A05 LANDSCAPE PLAN

A06 STATEMENT OF ENVIRONMENTAL EFFECTS

A07 WASTE MANAGEMENT PLAN A08 COST SUMMARY REPORT

A09 FLOOD STUDY



ALTERATIONS AND ADDITIONS


62 CHELMSFORD AVENUE, BELMORE NSW 2192

VIVYAN SABA






es.au

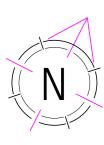

NUMBER OF STOREYS POSSIBLE OVERLOOKING PRIVATE OPEN SPACE REDUCED LEVELS **SITE DETAILS** SITE LENGTH (APPROX.) 36.75 m SITE WIDTH (APPROX.) 13.75 m

499.5 m²

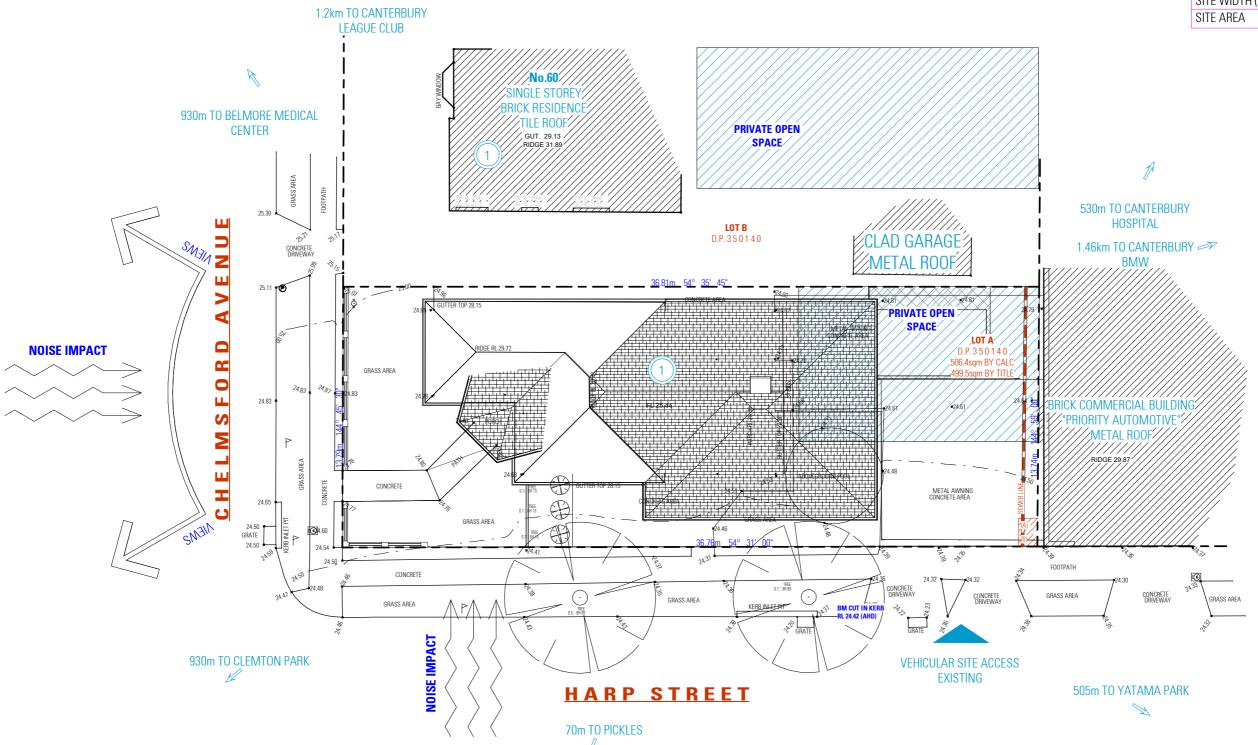

SITE ANALYSIS PLAN

NOT FOR CONSTRUCTION

NOTES

ALL DIMENSIONS ARE IN MILLIMETERS
 VERIFY ALL DIMENSIONS ON SITE
 3. DO NOT SCALE, USE FIGURED DIMENSIONS ONLY
 4. VERIFY ALL DISCREPANCIES WITH THE DESIGNER
 5. ALL WORKS TO COMPLY WITH THE NATIONAL
 CONSTRUCTION CODE (B.C.A.) & AUSTRALIAN STANDARDS

COPYRIGHT
THESE DRAWINGS HAVE BEEN PREPARED BY ES DESIGN, AND SHALL REMAIN THE PROPERTY OF THE SAME. NO PORTION OF THESE DRAWINGS, WHETHER IN PART OR WHOLE, SHALL BE USED IN ANY FORM, DUPLICATED OR OTHERWISE, WITHOUT PRIOR WRITTEN PERMISSION OF THE ARCHITECTJ DESIGNER. THESE DRAWINGS ARE SUBJECT TO COPYRIGHT LAWS.





ALTERATIONS AND ADDITIONS | DRAWING

DESIGN BENITA ZEAITER


DRAFTED JOSEPH YOUSSEF

BELMORE NSW 2192

62 CHELMSFORD AVENUE


SITE ANALYSIS PLAN

VIVYAN SABA ISSUE A 20.05.24

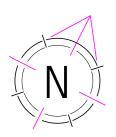

- REFER TO LANDSCAPE PLAN FOR DETAILS
- REFER TO STORMWATER PLAN FOR STORMWATER DETAILS / SEDIMENT AND EROSION CONTROL PLAN
- REFER TO STRUCTURAL PLAN FOR RETAINING WALL DETAILS • REFER TO STORMWATER PLAN AND BASIX REPORT FOR
- RAINWATER TANK DETAILS • ALL BOUNDARY FENCING TO BE MAINTAINED OR

	SITE CA	ALCULATIONS		
ITEM		REQU	IRED	PROPOSED
TOTAL SITE AREA (PARENT LOT)		>400.	00 sqm	506.4 sqm
PROPOSED GFA		278.5	2 sqm	148.93 sqm
DEEP SOIL AREA (SITE)	(MIN. 2.5m WIDE)	>20%	101.28 sqm	103.24 sqm (20.38%)
SITE COVERAGE		<50%	253.20 sqm	210.69 sgm (41.84%)

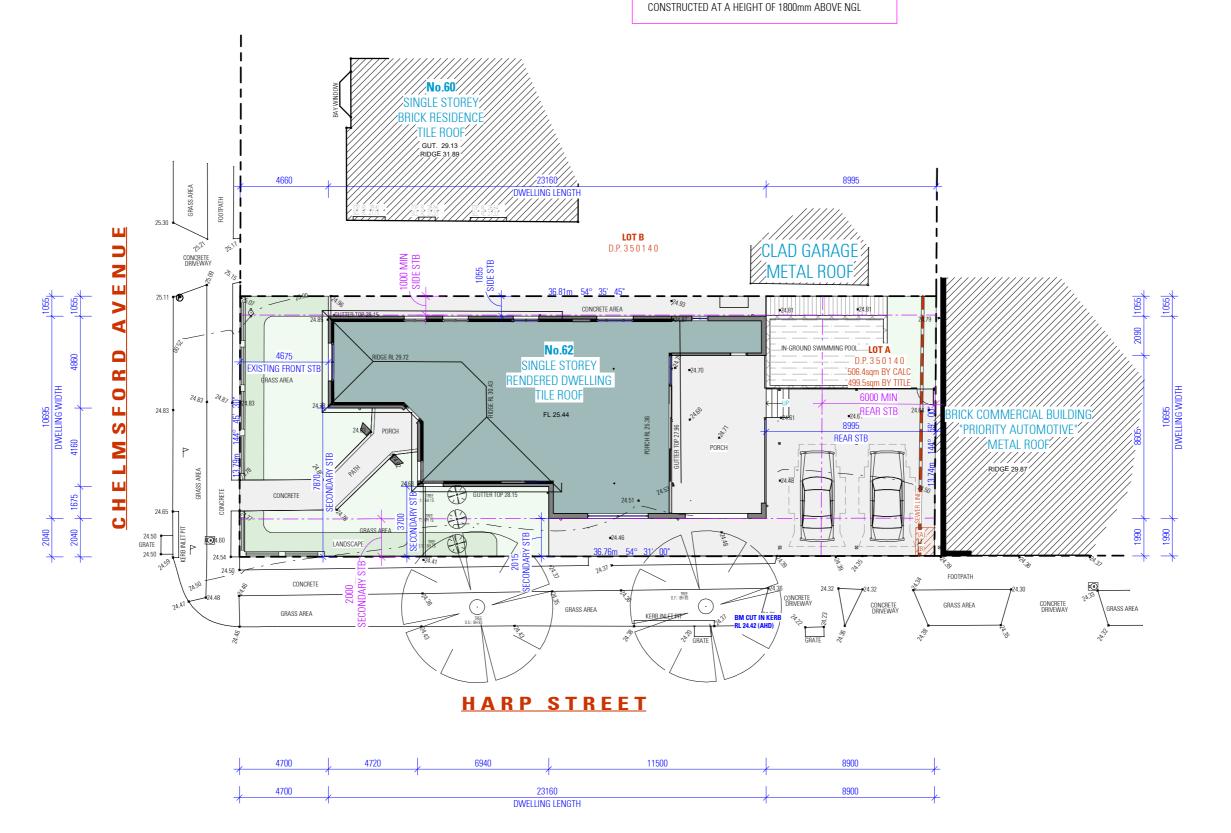

PROPOSED SITE PLAN

NOT FOR CONSTRUCTION

	SITE LEGEND						
	ITEM	SYMBOL					
<u></u>	GROUND FLOOR AREA						
KEY	LINE OF FIRST FLOOR	 					
	SITE BOUNDARY						

NOTES

1. ALL DIMENSIONS ARE IN MILLIMETERS
 2. VERIFY ALL DIMENSIONS ON SITE
 3. DO NOT SCALE, USE FIGURED DIMENSIONS ONLY
 4. VERIFY ALL DISCREPANCIES WITH THE DESIGNER
 5. ALL WORKS TO COMPLY WITH THE NATIONAL
 CONSTRUCTION CODE (B.C.A) & AUSTRALIAN STANDARDS

COPYRIGHT

THESE DRAWINGS HAVE BEEN PREPARED BY ES DESIGN, AND SHALL REMAIN THE PROPERTY OF THE SAME. NO PORTION OF THESE ORAWINGS, WHETHER IN PART OR WHOLE, SHALL BE USED IN ANY FORM, DUPLICATED OR OTHERWISE, WITHOUT PRIOR WRITTEN PERMISSION OF THE ARCHITECTY DESIGNER. THESE DRAWINGS ARE SUBJECT TO COPYRIGHT LAWS.





ALTERATIONS AND ADDITIONS | DRAWING


DESIGN BENITA ZEAITER


62 CHELMSFORD AVENUE


BELMORE NSW 2192


PROPOSED SITE PLAN


VIVYAN SABA ISSUE A 20.05.24

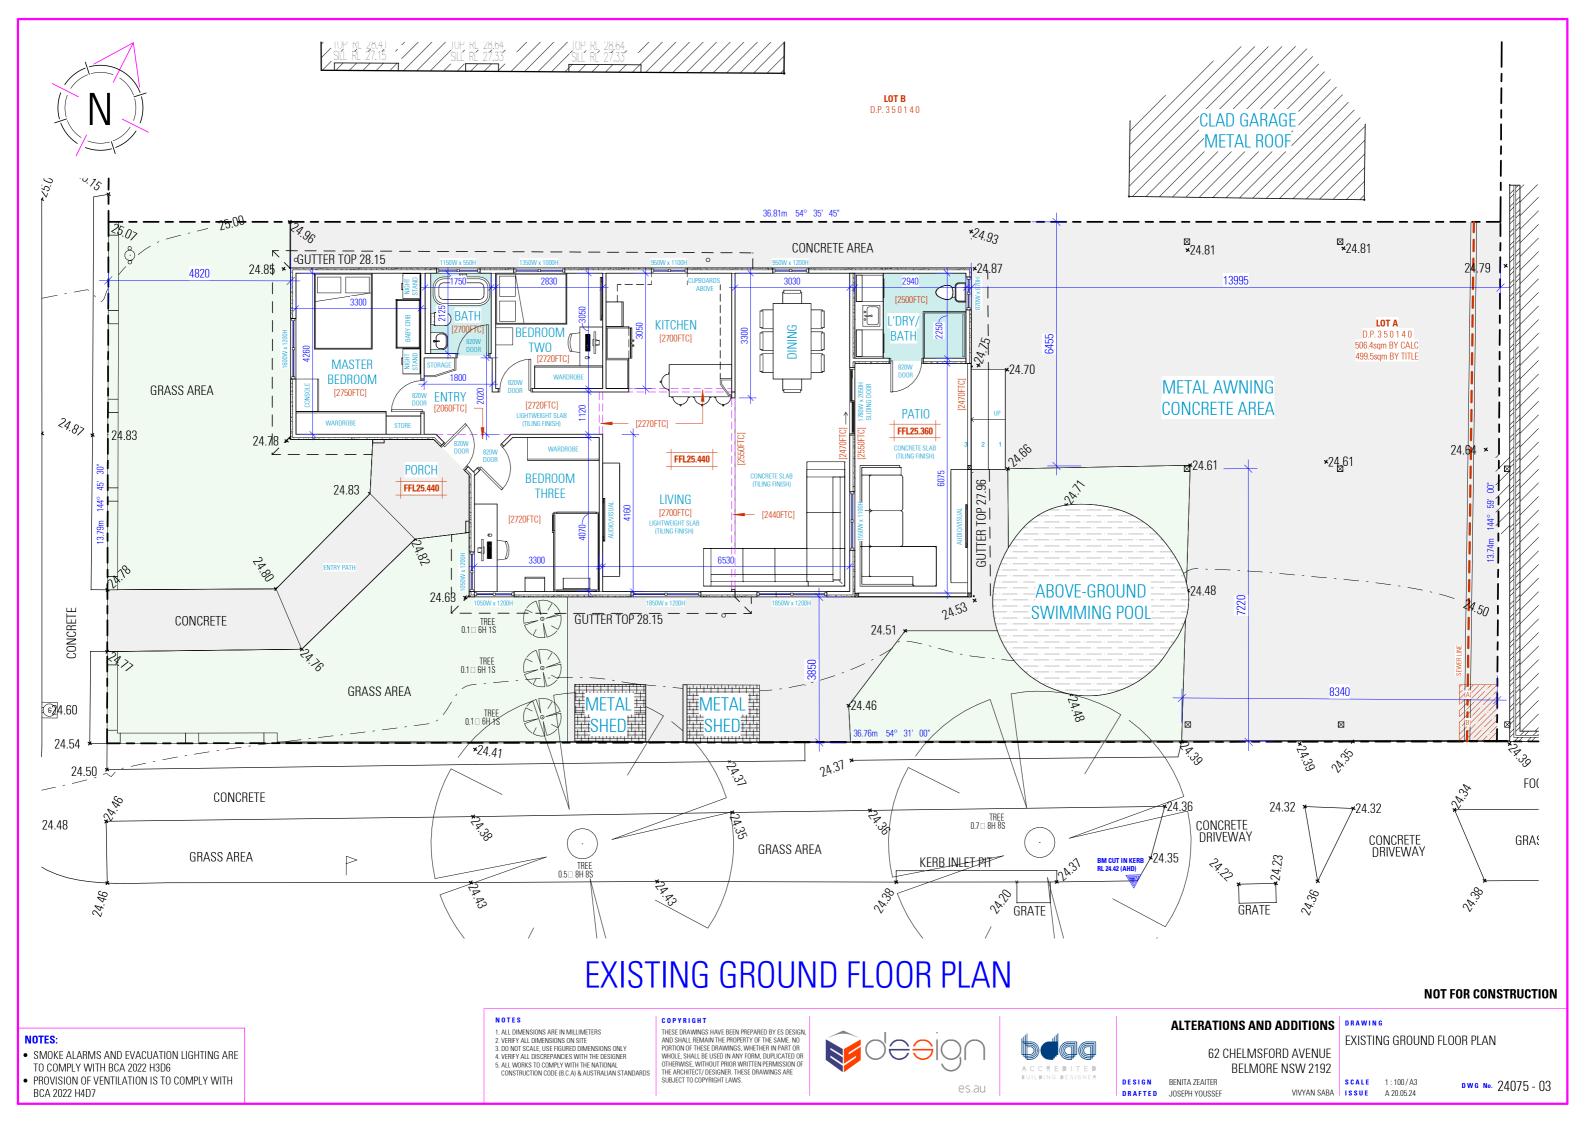


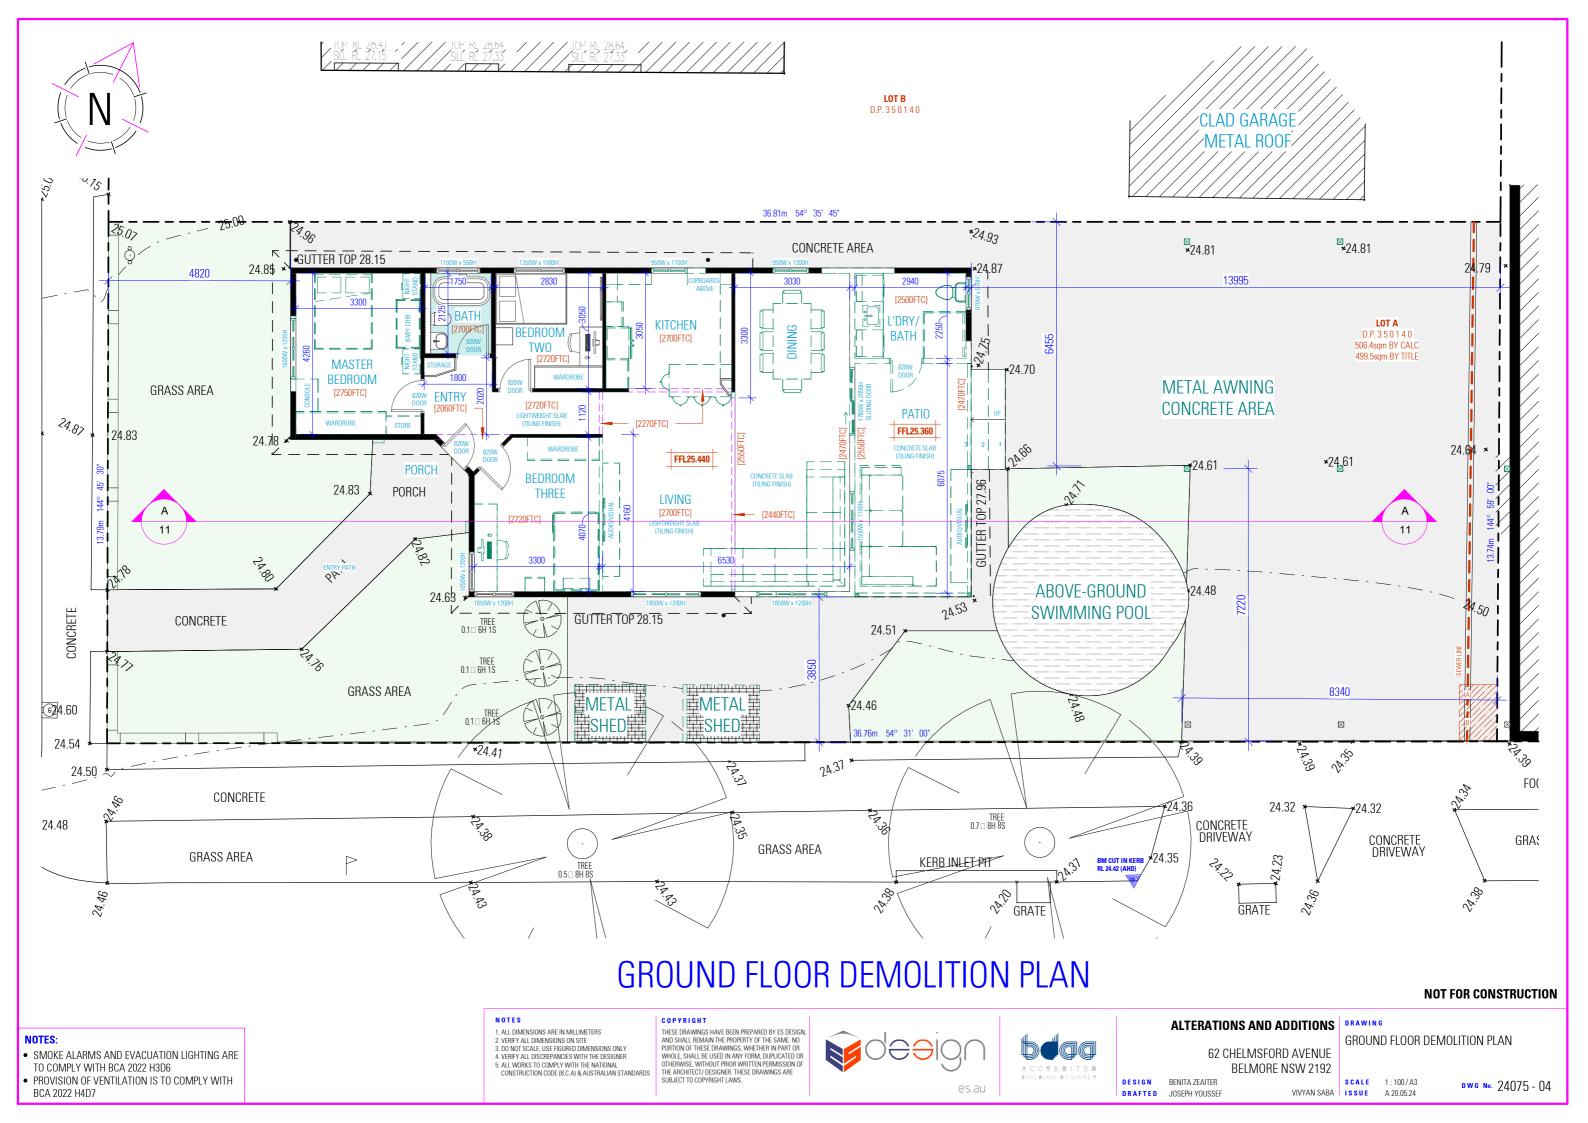


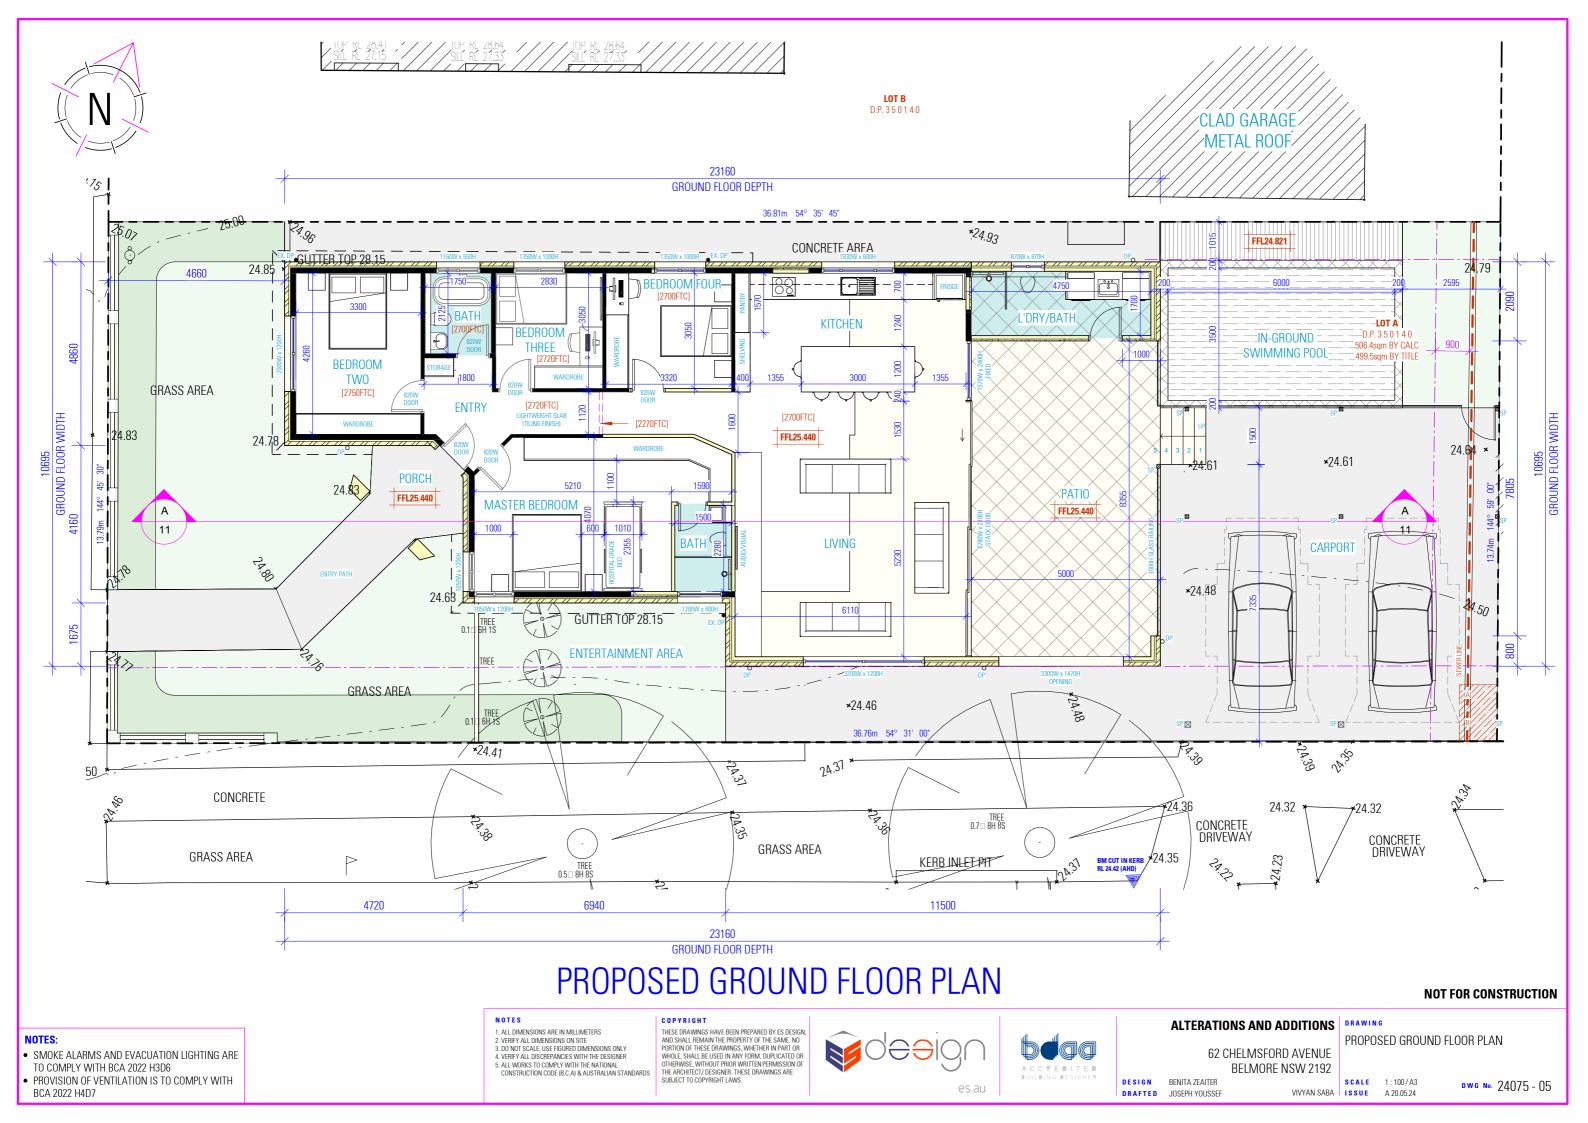

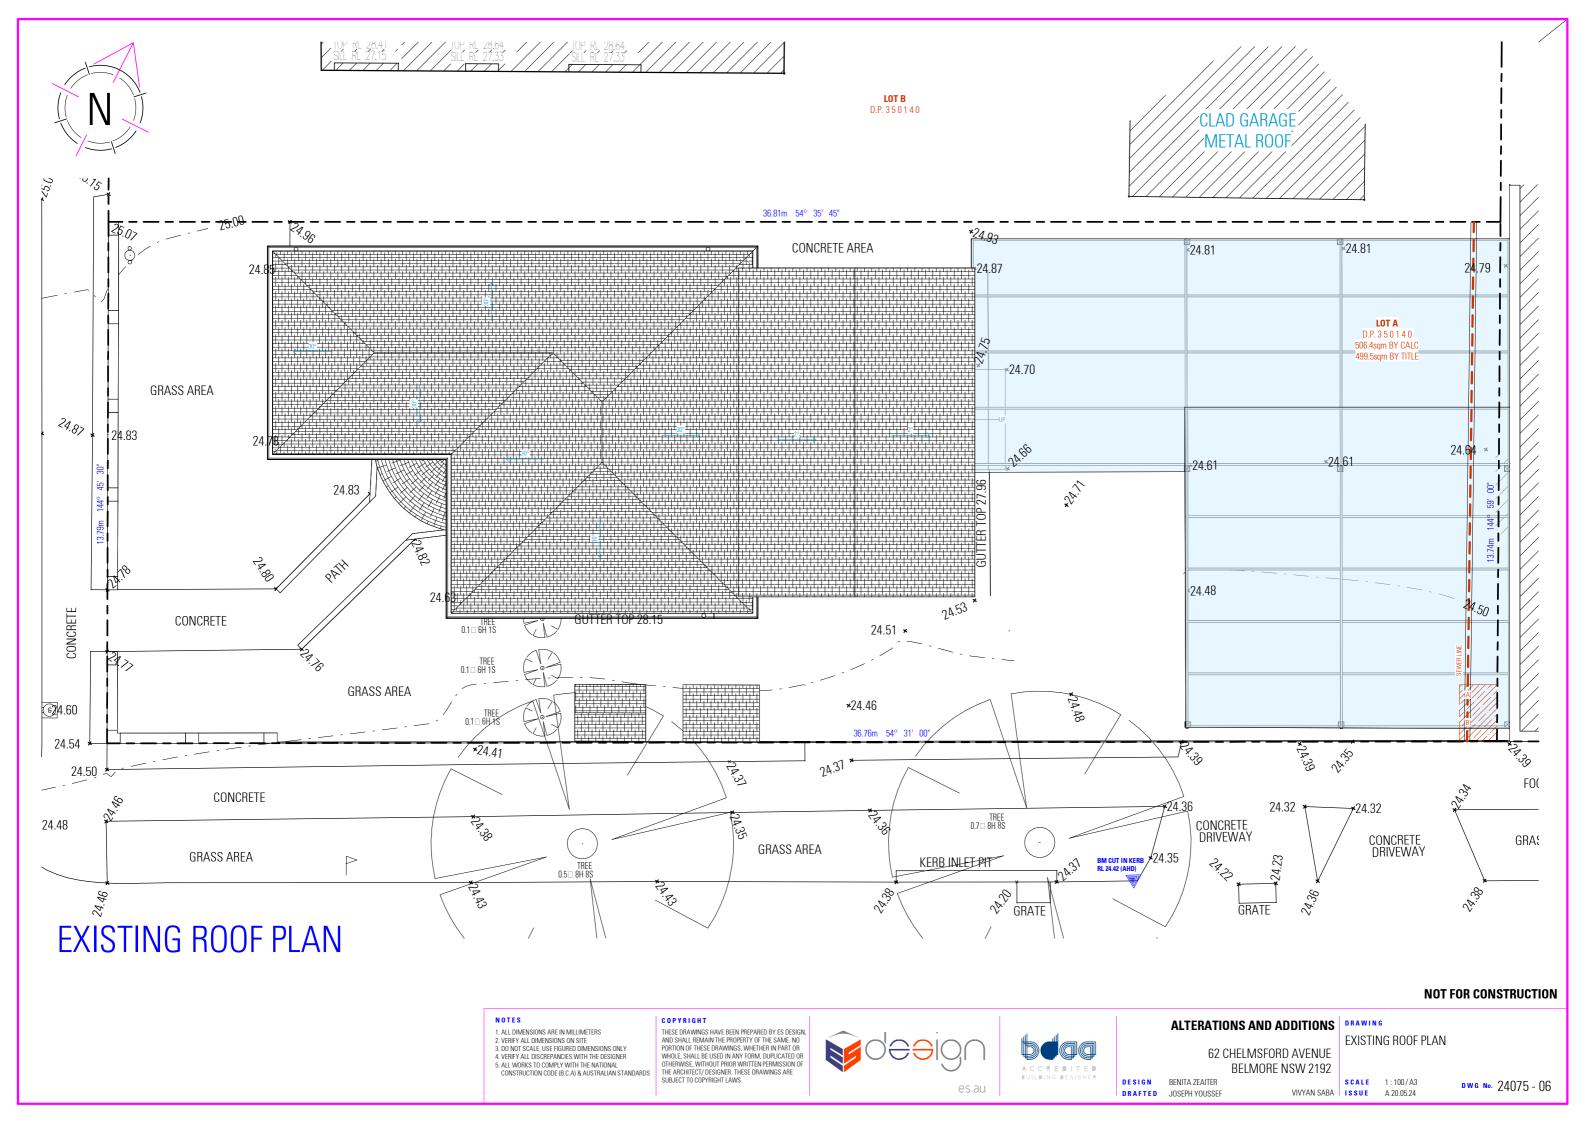

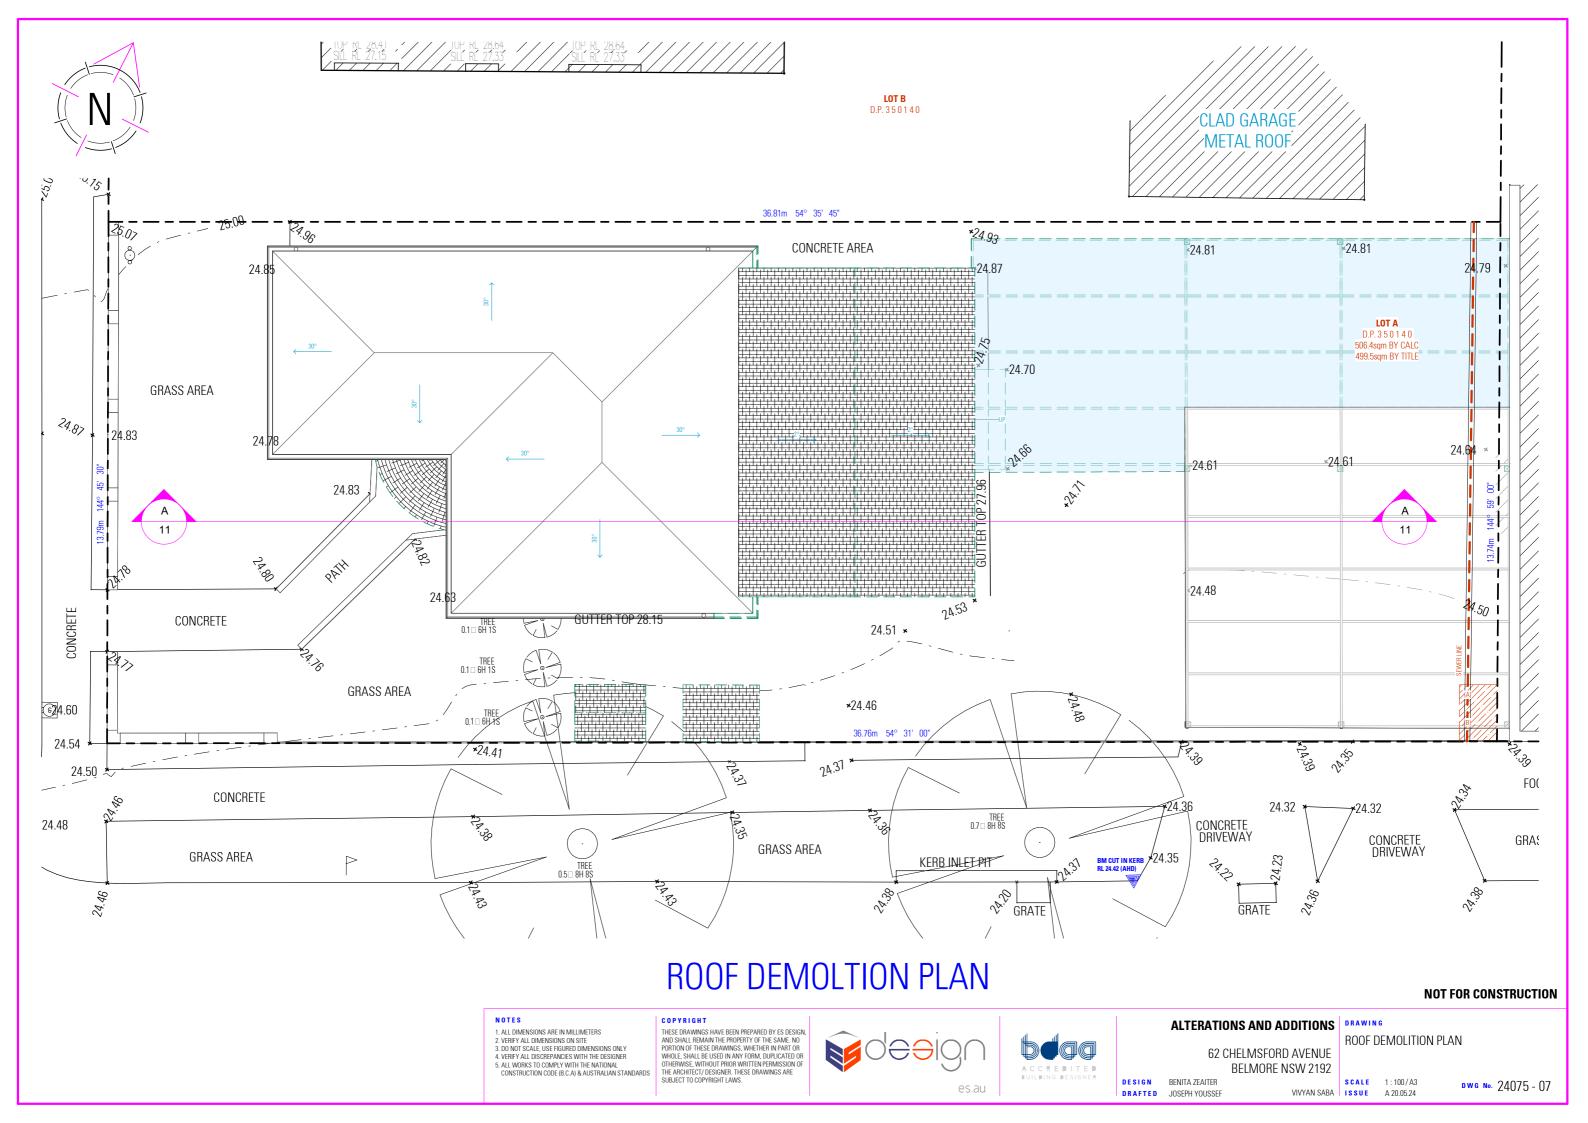


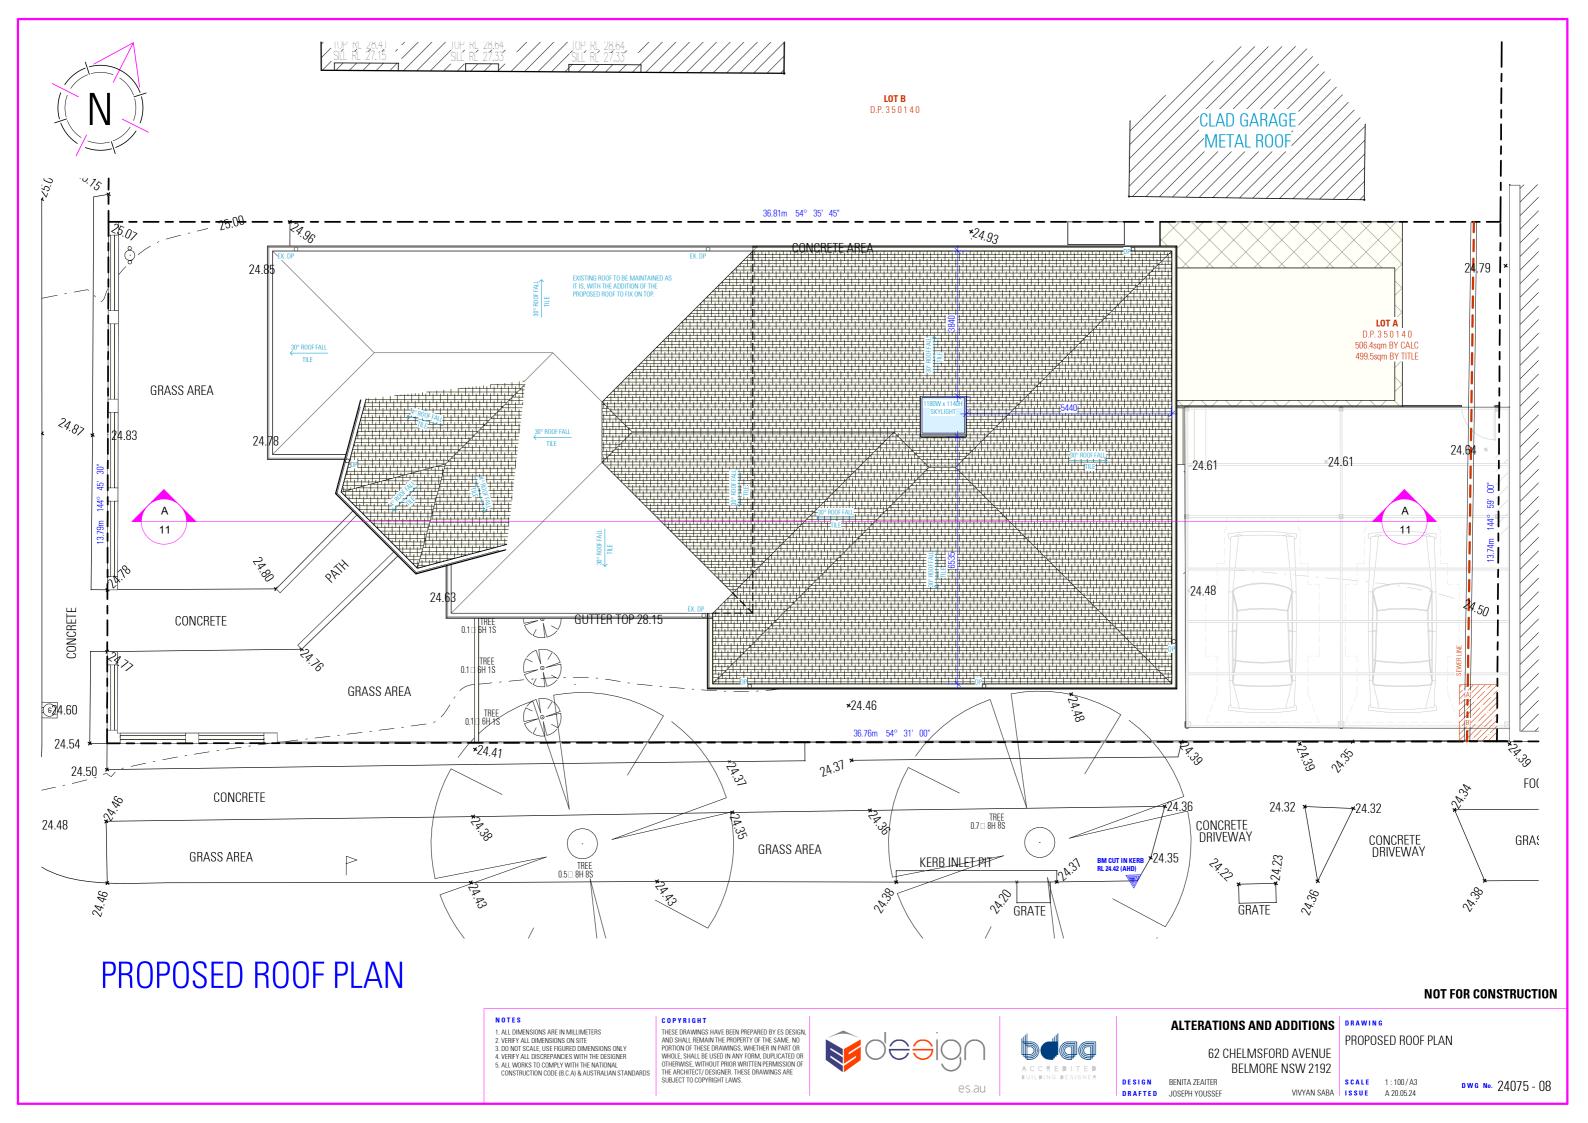

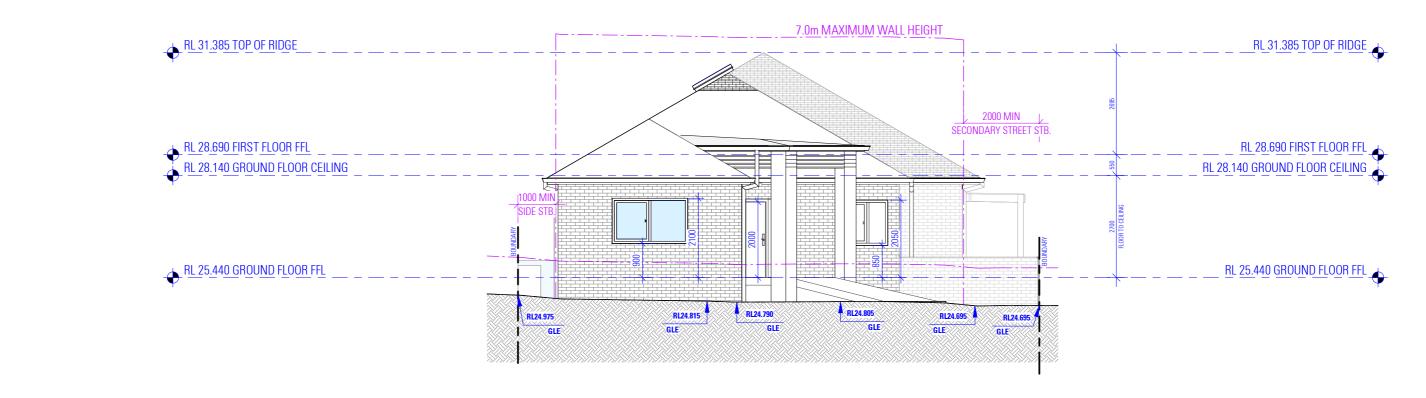

SOUTH WEST ELEVATION

AS SEEN FROM CHELMSFORD AVENUE

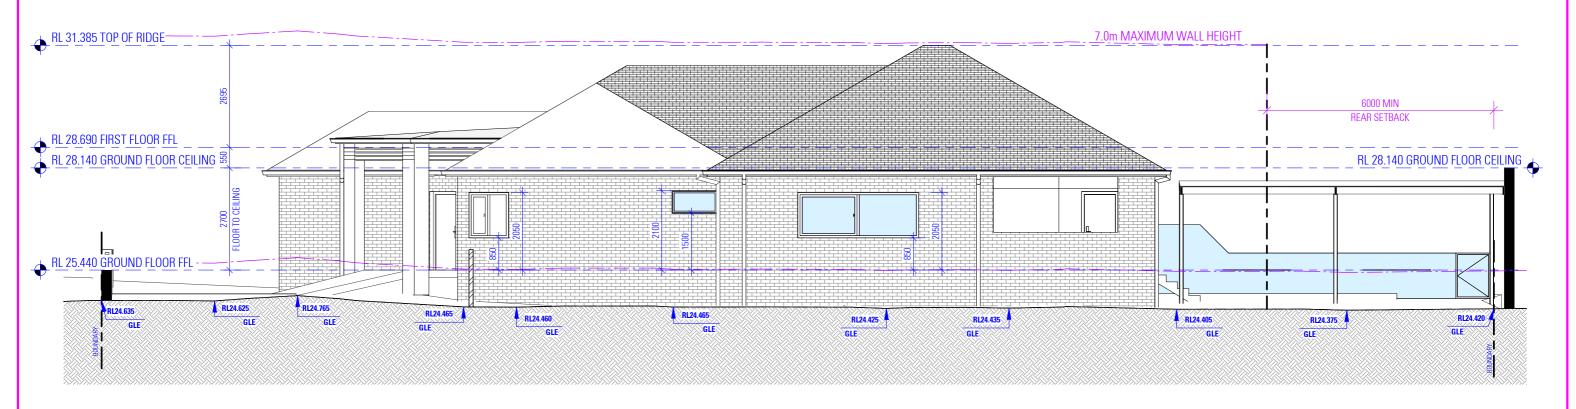

SOUTH EAST ELEVATION

NOT FOR CONSTRUCTION

NOTES

ALL DIMENSIONS ARE IN MILLIMETERS
 VERIFY ALL DIMENSIONS ON SITE
 3. DO NOT SCALE, USE FIGURED DIMENSIONS ONLY
 VERIFY ALL DISCREPANCIES WITH THE DESIGNER
 5. ALL WORKS TO COMPLY WITH THE NATIONAL
 CONSTRUCTION CODE (B.C.A) & AUSTRALIAN STANDARDS

COPYRIGHT

THESE DRAWINGS HAVE BEEN PREPARED BY ES DESIGN, AND SHALL REMAIN THE PROPERTY OF THE SAME. NO PORTION OF THESE DRAWINGS, WHETHER IN PART OR WHOLE, SHALL BUSED IN ANY FORM, DUPLICATED OR OTHERWISE, WITHOUT PRIOR WHITTEN PERMISSION OF THE ARCHITECT) DESIGNER. THESE DRAWINGS ARE SUBJECT TO COPYRIGHT LAWS.




ALTERATIONS AND ADDITIONS | DRAWING 62 CHELMSFORD AVENUE | ELEVATION BELMORE NSW 2192


DESIGN BENITA ZEAITER

SOUTH WEST AND SOUTH EAST

VIVYAN SABA ISSUE A 20.05.24

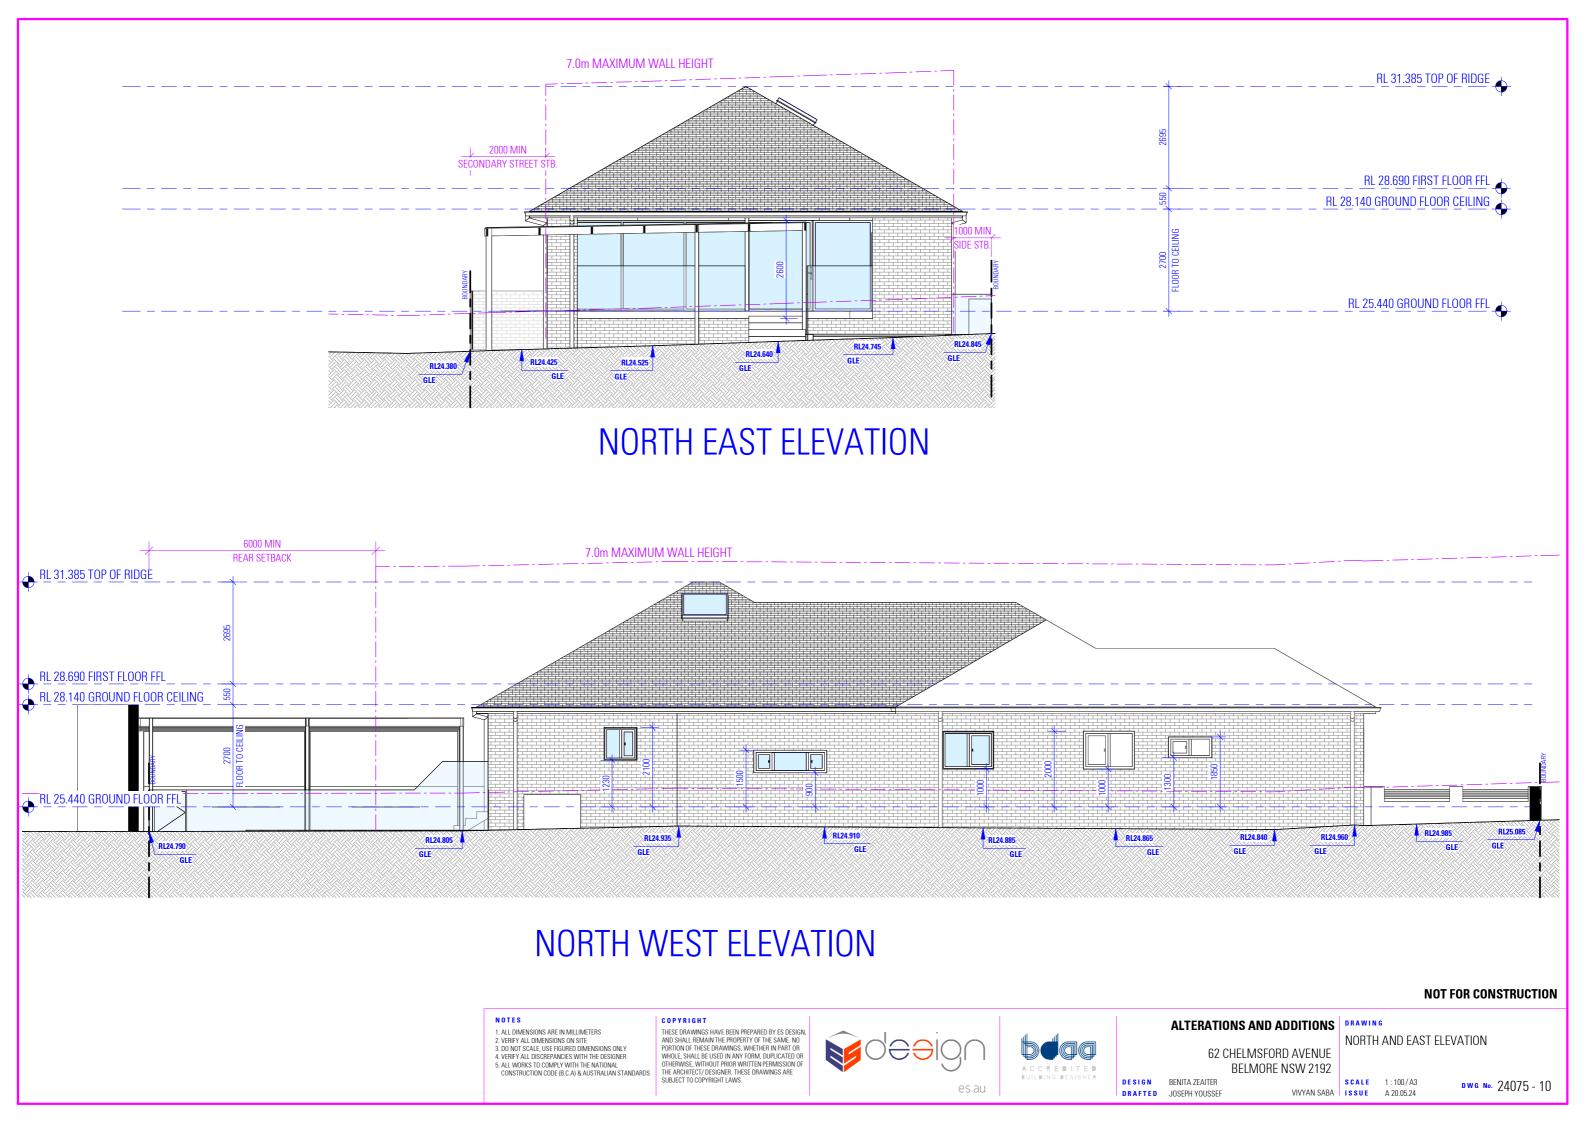

. THE ITEMS PROVIDED ABOVE ARE A GENERAL LIST OF WALL TYPES. VERIFY ALL DISCREPANCIES WITH THE DESIGNER BEFORE COMMENCING CONSTRUCTION

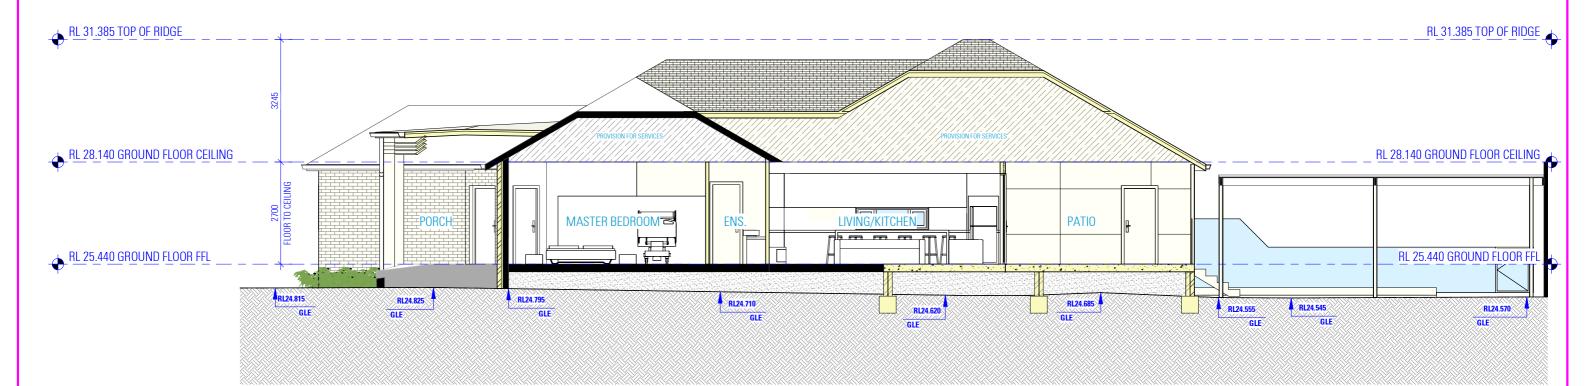

NATIONAL CONSTRUCTION CODE (NCC) FARTHWORKS AND EXCAVATIONS ARE TO BE CARRIED OUT IN ACCORDANCE WITH BCA 2022 H1D3 AND HOUSING PROVISIONS PART 3.2

- **STORM WATER** POWDER COATED ALUMINIUM GUTTERS & DOWNPIPES. REFER TO STORMWATER PLAN FOR ALL SITE DRAINAGE
- DETAILS AND CALCULATIONS.

NATIONAL CONSTRUCTION CODE (NCC) DRAINAGE IS TO BE IN ACCORDANCE WITH BCA 2022 H2D2

4. REFER TO BASIX CERTIFICATE FOR INSULATION REQUIREMENTS.

ROOF, WALL CLADDING, GUTTERS & DOWNPIPES ARE TO COMPLY WITH BCA 2022 H1D7 AND H2D6

TERMITE PROTECTION NATIONAL CONSTRUCTION CODE (NCC)

PROTECTION MUST BE IN ACCORDANCE WITH BCA 2022 H1D3 AND ABCB HOUSING PROVISIONS PART 3.4

FOOTINGS AND SLABS
• PROPOSED FOOTINGS TO THE SPECIFICATIONS OF A QUALIFIED

PRACTISING ENGINEER

NATIONAL CONSTRUCTION CODE (NCC) . FOOTINGS AND SLABS ARE TO BE DESIGNED AND CONSTRUCTED IN ACCORDANCE WITH BCA 2022 H1D4 AND

AUSTRALIAN STANDARD (AS)

PILED FOOTINGS ARE TO COMPLY WITH AS 2159-2009

 PROPOSED FLOOR CONSTRUCTION TO THE SPECIFICATIONS OF A QUALIFIED PRACTISING ENGINEER. ALL PORCHES, VERANDAHS & THE LIKE TO HAVE A 85mm STEPDOWN FROM INTERNAL AREAS UNLESS NOTED OTHERWISE

- FOR ALL REDUCED LEVELS REFER TO FLOOR PLANS (ENGINEERS
- DETAILS TO SUPERSEED-CONFIRM WITH DESIGNER) SUB FLOOR VENTILATION IS TO COMPLY WITH BCA 2022 H2D5

NATIONAL CONSTRUCTION CODE (NCC)

- STEEL AND TIMBER FRAMING AND STRUCTURAL STEEL SECTIONS ARE TO COMPLY WITH BCA 2022 H1D6 MASONRY, MASONRY COMPONENTS AND ACCESSORIES, AND WEATHERPROOFING OF MASONRY ARE TO COMPLY
- WITH BCA 2022 H1D5 AND H2D4 . SOUND INSULATION IS TO BE IN ACCORDANCE WITH BCA
- REINFORCED AUTOCLAVED AERATED CONCRETE IS TO COMPLY WITH AS 5146.1-2015
- CONCRETE POST-INSTALLED AND CAST-IN FASTENINGS IS TO COMPLY WITH SA TA 101
- ROOF AND WALL CLADDING ARE TO COMPLY WITH BCA 2022

STRUCTURE

- NATIONAL CONSTRUCTION CODE (NCC)

 STAIR CONSTRUCTION IS TO COMPLY WITH PART 3.9.1 STRUCTURAL DESIGN TO BE IN ACCORDANCE WITH ACCEPTABLE CONSTRUCTION MANUALS AS LISTED IN PART
- . ATTACHMENT OF FRAMED DECKS AND BALCONIES TO EXTERNAL WALLS OF BUILDINGS USING A WALING PLATE IS TO COMPLY WITH BCA 2022 H1D11

EXTERNAL WATERPROOFING NATIONAL CONSTRUCTION CODE (NCC)

EXTERNAL WATERPROOFING IS TO COMPLY WITH BCA 2022

GLAZING• POWDER COATED ALUMINIUM FRAMED GLASS WINDOWS & DOORS LINLESS NOTED OTHERWISE

NATIONAL CONSTRUCTION CODE (NCC)

• ALL GLAZING IS TO BE IN ACCORDANCE WITH BCA 2022 H1D8

NATIONAL CONSTRUCTION CODE (NCC) ROOF CLADDING SHALL BE CARRIED OUT IN ACCORDANCE

- AUSTRALIAN STANDARD (AS)
 INSTALLATION OF ROOF TILES AS 2050
- DESIGN & INSTALLATION OF SHEET ROOF & WALL CLADDING -

- NATIONAL CONSTRUCTION CODE (NCC)

 THE FIRE HAZARD PROPERTIES OF MATERIALS ARE TO COMPLY
- WITH BCA 2022 H3D2 FIRE SEPARATION OF EXTERNAL WALLS IS TO COMPLY WITH BCA 2022 H3D3

 $\bullet \;\;$ Fire Protection of Separating walls and Floors is to

05-08

- FIRE SEPARATION OF GARAGE-TOP-DWELLINGS IS TO COMPLY
- SMOKE ALARMS AND EVACUATION LIGHTING ARE TO COMPLY WITH BCA 2022 H3D6

HEALTH & AMENITY

ALL BATHROOM, ENSUITES AND LAUNDRIES TO HAVE FLOOR WASTES AND BE SETDOWN AND WATERPROOFED.

NATIONAL CONSTRUCTION CODE (NCC)

- WET AREAS ARE TO COMPLY WITH BCA 2022 H4D2 MATERIALS AND INSTALLATION OF WET AREA COMPONENTS AND SYSTEMS ARE TO COMPLY WITH BCA 2022 H4D3
- ROOM HEIGHTS ARE TO COMPLY WITH BCA 2022 H4D4 PROVISION OF LIGHT IS TO COMPLY WITH BCA 2022 H4D6 PROVISION OF VENTILATION IS TO COMPLY WITH BCA 2022
- SOUND INSULATION IS TO COMPLY WITH BCA 2022 H4D8 CONDENSATION MANAGEMENT IS TO COMPLY WITH BCA

- SAFE MOVEMENT & ACCESS
 NATIONAL CONSTRUCTION CODE (NCC) STAIRWAY AND RAMP CONSTRUCTION ARE TO COMPLY WITH
- . BARRIERS AND HANDRAILS ARE TO COMPLY WITH BCA 2022
- THE WINDOW IS TO BE FITTED WITH EITHER A DEVICE TO RESTRICT THE WINDOW OPENING, OR A SUITABLE SCREEN, SO
- A 125mm SPHERE CANNOT PASS THROUGH.

 THE DEVICE OR SCREEN CAN HAVE A CHILD RESISTANT RELEASE MECHANISM (E.G. A KEY LOCK) WHICH CAN ENABLE THE DEVICE OR SCREEN TO BE REMOVED. UNLOCKED OR OVERRIDDEN. (SO FOR EXAMPLE, THE WINDOW CAN BE CLEANED)
- A BARRIER IS NOT REQUIRED FOR WINDOWS 1.7m OR MORE ABOVE THE FLOOR LEVEL.

EXTERNAL FINISHES• REFER TO SCHEDULE OF EXTERNAL MATERIALS, COLOURS AND FINISHES FOR MORE DETAILS.

ANCILLARY PROVISIONS AND ADDITIONAL CONSTRUCTION REQUIREMENTS

NATIONAL CONSTRUCTION CODE (NCC) • SWIMMING POOLS ARE TO COMPLY WITH BCA 2022 NSW

- CONSTRUCTION IN BUSHFIRE PRONE AREAS IS TO COMPLY
- WITH BCA 2022 NSW H7D4 HEATING APPLIANCES, FIREPLACES, CHIMNEYS AND FLUES ARE TO COMPLY WITH BCA 2022 H7D5

LANDSCAPE• REFER TO LANDSCAPE PLAN FOR ALL PLANTING AND OUTDOOR SURFACE TREATMENTS

STRUCTURAL SOFTWARE USED IN COMPUTER AIDED DESIGN OF A BUILDING OR STRUCTURE THAT USES DESIGN CRITERIA BASED ON THE DEEMED-TO-SATISFY PROVISIONS OF NCC VOLUME TWO AND THE ABCB HOUSING PROVISIONS. INCLUDING ITS REFERENCED DOCUMENTS, FOR THE DESIGN OF STEEL OR TIMBER TRUSSED ROOF AND FLOOR SYSTEMS AND FRAMED BUILDING SYSTEMS, MUST COMPLY WITH THE ABCB PROTOCOL FOR STRUCTURAL SOFTWARE WHERE RELEVANT, AS REFERRED TO IN ABCB HOUSING

THE DEVELOPMENT HAS BEEN DESIGNED TO BEST MEET THE GUIDELINES OF COUNCIL & THE NATIONAL

(ALL WORK ON SITE SHALL BE CARRIED OUT IN A SIMILAR MANNER TO ADHERE TO THE REQUIREMENTS OF COUNCIL AND THE NCC)

MINOR CHANGES TO BUILDING FORM AND CONFIGURATION MAY BE REQUIRED WHEN DRAWINGS ARE SUBSEQUENTLY PREPARED FOR CONSTRUCTION

PURPOSES AFTER THE GRANT OF DEVELOPMENT CONSENT **NOT FOR CONSTRUCTION**

NOTES

ALL DIMENSIONS ARE IN MILLIMETERS
 VERIFY ALL DIMENSIONS ON SITE
 DO NOT SCALE, USE FIGURED DIMENSIONS ONLY

4. VERIFY ALL DISCREPANCIES WITH THE DESIGNER 5. ALL WORKS TO COMPLY WITH THE NATIONAL CONSTRUCTION CODE (B.C.A) & AUSTRALIAN STANDARDS

COPYRIGHT

SECTION

THESE DRAWINGS HAVE BEEN PREPARED BY ES DESIGN AND SHALL REMAIN THE PROPERTY OF THE SAME. NO PORTION OF THESE DRAWINGS, WHETHER IN PART OR WHOLE, SHALL BE USED IN ANY FORM, DUPLICATED OR OTHERWISE, WITHOUT PRIOR WRITTEN PERMISSION OF THE ARCHITECT/ DESIGNER. THESE DRAWINGS ARE SUBJECT TO COPYRIGHT LAWS.

ALTERATIONS AND ADDITIONS | DRAWING

62 CHELMSFORD AVENUE

BELMORE NSW 2192

SECTION VIEW

DESIGN BENITA ZEAITER DRAFTED JOSEPH YOUSSER

VIVYAN SABA ISSUE

SCHEDULE OF EXTERNAL MATERIALS, COLOURS AND FINISHES

- 1 BRISTILE ROOFIND ROOF TILES RANGE:INNOVA COLOUR:TURRON OR ACCEPTABLE EQUIVALENT TO MATCH WITH EXISTING ROOF
- PGH FACE BRICK RANGE:DARK AND STORMY COLOUR:LIGHTNING OR ACCEPTABLE EQUIVALENT
- 3 DULUX POWDER-COATED ALUMINIUM WINDOWS AND GLASS DOORS RANGE:DURALLOY COLOUR: MONUMENT SATIN OR ACCEPTABLE EQUIVALENT
- 4 CEMENT RENDER AND PAINT EXTERNAL WALLS RANGE: DULUX COLOUR:TIMELESS GREY OR ACCEPTABLE EQUIVALENT
- NEWTECHWOOD EXTERNAL CLADDING FOR FEATURE ENTRY RANGE: COMPOSITE CLADDING COLOUR: TEAK OR ACCEPTABLE EQUIVALENT



AS SEEN FROM CHELMSFORD AVENUE

NOT FOR CONSTRUCTION

NOTES

1. ALL DIMENSIONS ARE IN MILLIMETERS

 VERIFY ALL DIMENSIONS ON SITE
 ON NOT SCALE, USE FIGURED DIMENSIONS ONLY
 VERIFY ALL DISCREPANCIES WITH THE DESIGNER 5. ALL WORKS TO COMPLY WITH THE NATIONAL CONSTRUCTION CODE (B.C.A) & AUSTRALIAN STANDARDS

THESE DRAWINGS HAVE BEEN PREPARED BY ES DESIGN, AND SHALL REMAIN THE PROPERTY OF THE SAME. NO PORTION OF THESE ORAWINGS, WHETHER IN PART OR WHOLE, SHALL BE USED IN ANY FORM, DUPLICATED OR OTHERWISE, WITHOUT PRIOR WRITTEN PERMISSION OF THE ARCHITECTY DESIGNER. THESE DRAWINGS ARE SUBJECT TO COPYRIGHT LAWS.

COPYRIGHT





ALTERATIONS AND ADDITIONS | DRAWING


DESIGN BENITA ZEAITER

DRAFTED JOSEPH YOUSSEF


62 CHELMSFORD AVENUE | COLOURS AND FINISHES BELMORE NSW 2192

SCHEDULE OF EXTERNAL MATERIALS,


VIVYAN SABA ISSUE A 20.05.24

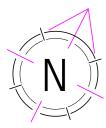

IN-GROUND SWIMMING POOL DETAILS

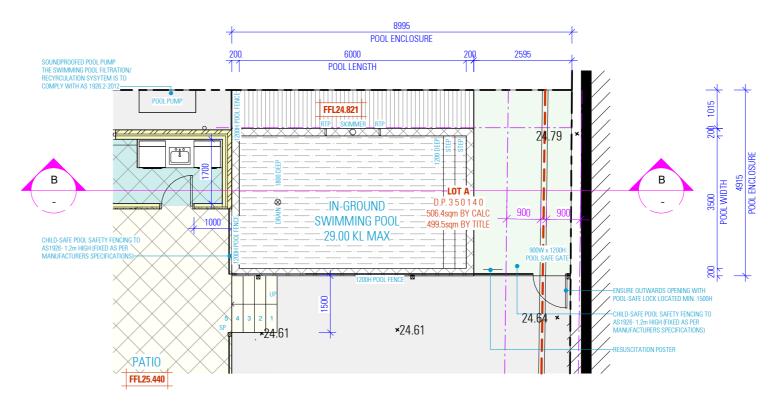

PROPOSED SWIMMING POOL PLAN

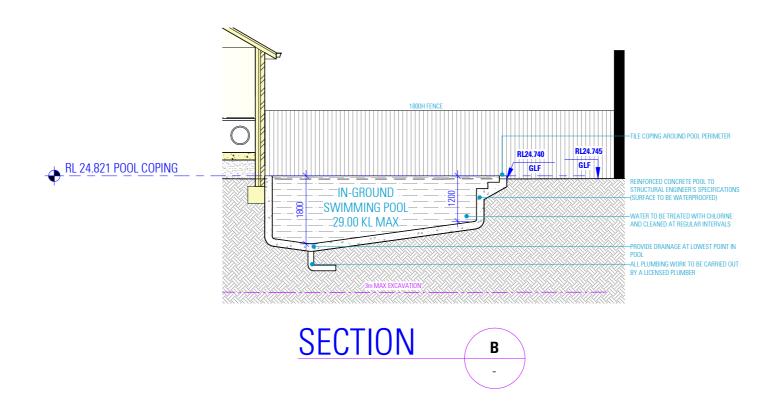

NOT FOR CONSTRUCTION

NOTES

1. ALL DIMENSIONS ARE IN MILLIMETERS. 2. VERIFY ALL DIMENSIONS ON SITE
3. DO NOT SCALE, USE FIGURED DIMENSIONS ONLY
4. VERIFY ALL DISCREPANCIES WITH THE DESIGNER 5. ALL WORKS TO COMPLY WITH THE NATIONAL



ALTERATIONS AND ADDITIONS | DRAWING

DESIGN BENITA ZEAITER

DRAFTED JOSEPH YOUSSEF

62 CHELMSFORD AVENUE BELMORE NSW 2192

IN-GROUND SWIMMING POOL DETAILS

SCALE 1:100/A3

DWG No. 24075 - 13 VIVYAN SABA ISSUE

SPA POOLS ARE ALSO COVERED BY THE LEGISLATION AND SHOULD BE SEPARATED BY A CHILD-RESISTANT POOL SAFETY BARRIER IN ACCORDANCE

SWIMMING POOL REQUIREMENTS:

GENERAL REQUIREMENTS

ALL POOLS MUST BE SEPARATED FROM RESIDENTIAL BUILDINGS AND ADJOINING PUBLIC OR PRIVATE PROPERTIES BY A COMPLYING CHILDRESISTANT BARRIER (MUST BE IN ACCORDANCE WITH THE REGULATIONS AND AS1926.1-2007 SWIMMING POOL SAFETY).

NO DOOR ACCESS FROM A RESIDENTIAL BUILDING INTO AN OUTDOOR POOL IS PERMITTED
ONLY STRUCTURES ASSOCIATED WITH THE POOL (FILTER HOUSING, ETC.) ARE PERMITTED WITHIN THE ENCLOSED POOL AREA

STRUCTURES SUCH AS CLOTHES LINES, BARBEQUE, SHEDS, ENTERTAINMENT STRUCTURE, OUTSIDE TOILETS, ETC. MUST ALL BE LOCATED OUTSIDE

SWIMMING POOL FENCING AND OTHER BARRIERS TO BE PROVIDED TO THE POOL AREA IN ACCORDANCE WITH THE SWIMMING POOLS ACT 1992.
BOUNDARY FENCE TO BE 1 Bm IN HEIGHT, MEASURED FROM INSIDE OF THE FENCING,
SWIMMING POOL FENCING TO BE AT LEAST 1.2m HIGH, MEASURED ON THE OUTSIDE OF THE FENCING,
SWIMMING POOL FENCING TO BE AT LEAST 1.2m HIGH, MEASURED ON THE OUTSIDE OF THE FENCING.
MINIMUM 900mm SEPARATION BETWEEN THE UPPER AND LOWER HORIZONTAL MEMBERS TO MAINTAIN NON-CLIMBABLE ZONE
HORIZONTAL MEMBERS OF THE FENCE SHOLD BE PLACED ON THE INSIDE OF THE FENCE AND BE AT LEAST 900mm APART.
THE SPACING OF VERTICAL MEMBERS OF THE FENCE SHALL NOT EXCEED 100mm.
THE HEIGHT OF ANY OPENING BETWEEN THE BOTTOM OF THE FENCE AND FINISHED GROUND LEVEL SHALL NOT EXCEED 100mm.
ALL SWIMMING POOL FENCING TO BE MAINTAINED IN A GOOD CONDITION (ie. WITH NO HOLES, BROKEN OR LOOSE PALINGS).
NON-CLIMBABLE ZONE EXTENDS FROM THE POOL FENCE 300mm INTO THE POOL AREA AND 900mm OUTSIDE THE POOL AREA. TO PREVENT A CHILD
TO CLIMB OVER THE FENCE, CLIMBABLE OBJECTS SUCH AS BARBEQUES, FURNITURE, PLANTER BOXES, TREES OR SHIRBB ARE NOT PERMITTED
WITHIN THIS NON-CLIMBABLE ZONE
IF THE WALL OF THE HOUSE FORMS PART OF THE APPROVED CHILD-RESISTANT TO ACCORDANCE WITH THE REGULATIONS.

BEFORE1 AUGUST 1990), ALL DOOR AND WINDOW OPENINGS IN THE WALL/S MUST BE CHILD-RESISTANT IN ACCORDANCE WITH THE REGULATIONS

NO DOUBLE GATES ARE PERMITTED
GATES ARE NOT TO BE PROPEPED OPEN AT ANY TIME.
THE LATCHING DEVICE TO THE POOL GATE IS TO BE LOCATED A MINIMUM 1.5m ABOVE GROUND LEVEL AND 1.4m FROM THE HIGHEST LOWER
HORIZONTAL BARRIER MEMBER OR, ALTERNATIVELY, THE DEVICE IS TO BE LOCATED INSIDE THE GATE AND THE LATCHING DEVICE IS TO BE
APPROPRIATELY SHIELDED FROM THE OUTSIDE IN ACCORDANCE WITH AS 1926.1-2012 (EXCLUDING CLAUSE 2.8 OF THE STANDARD) TO ENSURE THE
LATCHING DEVICE IS ONLY ACCESSIBLE BY REACHING OVER THE GATE.
GATE WIDTH IS TO BE KEPT TO A MINIMUM INFO MORE THAN 1 METRE) TO MINIMISE THE POSSIBILITY OF THE WEIGHT OF THE GATE CAUSING THE
GATE TO DROP WITH THE SELF-LATCHING MECHANISM FAILING.

GATES TO THE SWIMMING POOL AREA ARE TO OPEN OUTWARDS AND ARE TO BE FULLY SELF-CLOSING AND SELF-LATCHING FROM ANY OPEN

WITH AUST HALLIAN STANDARD AS 1926.1-2007.
ALTERNATIVELY, THE SPA POOL MUST BE COVERED AND SECURED BY A LOCKABLE CHILD-SAFE STRUCTURE (SUCH AS A DOOR, LID, GRILLE OR MESH). SUCH LOCKABLE STRUCTURE MUST BE ABLE TO BE REMOVED/INSTALLED AND LOCKED BY A SINGLE PERSON.

WARNING SIGN AN APPROPRIATE RESUSCITATION WARNING SIGN (AVAILABLE FROM COUNCIL OR THE ROYAL LIFE SAVING SOCIETY) IS DISPLAYED IN A

PROMINANT POSITION IN THE IMMEDIATE VICINITY OF THE POOL AREA.

THE FOLLOWING WARNING STATEMENTS MUST BE CONTAINED WITHIN THE RESUSCITATION SIGN:

YOUNG CHILDREN SHOULD BE SUPERVISED WHEN USING THIS SWIMMING POOL

POOL GATES MUST BE KEPT CLOSED AT ALL TIMES

TO PREVENT CHILDREN ACCESSING THE POOL AREA.

POOL GATES MUST BE KEPT CLOSED AT ALL TIMES

KEP ARTICLES, OBJECTS AND STRUCTURES AT LEAST 900 MM CLEAR OF THE POOL FENCE AT ALL TIMES

THE RESUSCITATION SIGN MUST BE.

LEGIBLE FROM A DISTANCE OF AT LEAST THREE METRES


MAINTAINED IN A CLEARLY LEGIBLE CONDITION

REFER TO THE SWIMMING POOLS ACT 1992, THE SWIMMING POOLS REGULATION 2018 AND AUSTRALIAN STANDARD AS 1926.1-2012 (EXCLUDING CLAUSE 2.8 OF THE

COPYRIGHT


THESE DRAWINGS HAVE BEEN PREPARED BY ES DESIGN AND SHALL REMAIN THE PROPERTY OF THE SAME. NO PORTION OF THESE DRAWINGS, WHETHER IN PART OR WHOLE, SHALL BE USED IN ANY FORM, DUPLICATED OR OTHERWISE, WITHOUT PRIOR WRITTEN PERMISSION OF CONSTRUCTION CODE (B.C.A) & AUSTRALIAN STANDARDS THE ARCHITECT/ DESIGNER. THESE DRAWINGS ARE

SUBJECT TO COPYRIGHT LAWS.

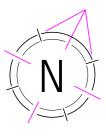

- REFER TO LANDSCAPE PLAN FOR DETAILS
- REFER TO STORMWATER PLAN FOR STORMWATER DETAILS / SEDIMENT AND EROSION CONTROL PLAN
- REFER TO STRUCTURAL PLAN FOR RETAINING WALL DETAILS | DETAILS
- REFER TO STORMWATER PLAN AND BASIX REPORT FOR RAINWATER TANK DETAILS
- ALL BOUNDARY FENCING TO BE MAINTAINED OR CONSTRUCTED AT A HEIGHT OF 1800mm ABOVE NGL

	SITE CA	ALCULATIONS		
ITEM		REQU	IIRED	PROPOSED
TOTAL SITE AREA (PARENT LOT)		>400.	00 sqm	506.4 sqm
PROPOSED GFA		278.5	2 sqm	148.93 sqm
DEEP SOIL AREA (SITE)	(MIN. 2.5m WIDE)	>20%	101.28 sqm	103.24 sqm (20.38%)
SITE COVERAGE		<50%	253.20 sqm	210.69 sqm (41.84%)
				•

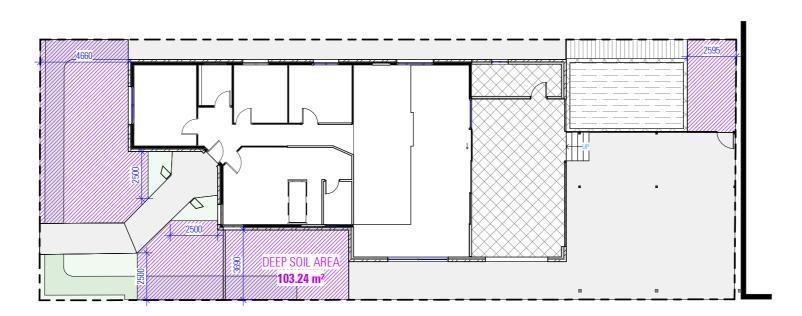

DEEP SOIL AREA CALCULATION PLAN

NOT FOR CONSTRUCTION

NOTES

COPYRIGHT

1. ALL DIMENSIONS ARE IN MILLIMETERS
2. VERIFY ALL DIMENSIONS ON SITE
3. DO NOT SCALE, USE FIGURED DIMENSIONS ONLY
4. VERIFY ALL DISCREPANCIES WITH THE DESIGNER
5. ALL WORKS TO COMPLY WITH THE NATIONAL
CONSTRUCTION CODE (B.C.A) & AUSTRALIAN STANDARDS

THE ARCHITECT DESIGNER THESE DRAWINGS, WHETHER IN PART OR
WHOLE, SHALE BUSED IN ANY FORM, DUPILCATED OR
OTHERWISE, WITHOUT PRIOR WRITTEN PERMISSION OF
THE ARCHITECT DESIGNER. THESE DRAWINGS ARE
SUBJECT TO COPYRIGHT LAWS.





ALTERATIONS AND ADDITIONS | DRAWING

62 CHELMSFORD AVENUE BELMORE NSW 2192

DEEP SOIL AREA CALCULATION SHEET

SCALE 1:200/A3

DWG No. 24075 - 14


DESIGN BENITA ZEAITER DRAFTED JOSEPH YOUSSEF

VIVYAN SABA ISSUE A 20.05.24



- REFER TO LANDSCAPE PLAN FOR DETAILS
- REFER TO STORMWATER PLAN FOR STORMWATER DETAILS / SEDIMENT AND EROSION CONTROL PLAN
- REFER TO STRUCTURAL PLAN FOR RETAINING WALL DETAILS REFER TO STORMWATER PLAN AND BASIX REPORT FOR
- RAINWATER TANK DETAILS
- ALL BOUNDARY FENCING TO BE MAINTAINED OR CONSTRUCTED AT A HEIGHT OF 1800mm ABOVE NGL

	SITE CA	ALCULATIONS		
ITEM		REQU	IRED	PROPOSED
TOTAL SITE AREA (PARENT LOT)		>400.	00 sqm	506.4 sqm
PROPOSED GFA		278.52	2 sqm	148.93 sqm
DEEP SOIL AREA (SITE)	(MIN. 2.5m WIDE)	>20%	101.28 sqm	103.24 sqm (20.38%)
SITE COVERAGE		<50%	253.20 sqm	210.69 sqm (41.84%)

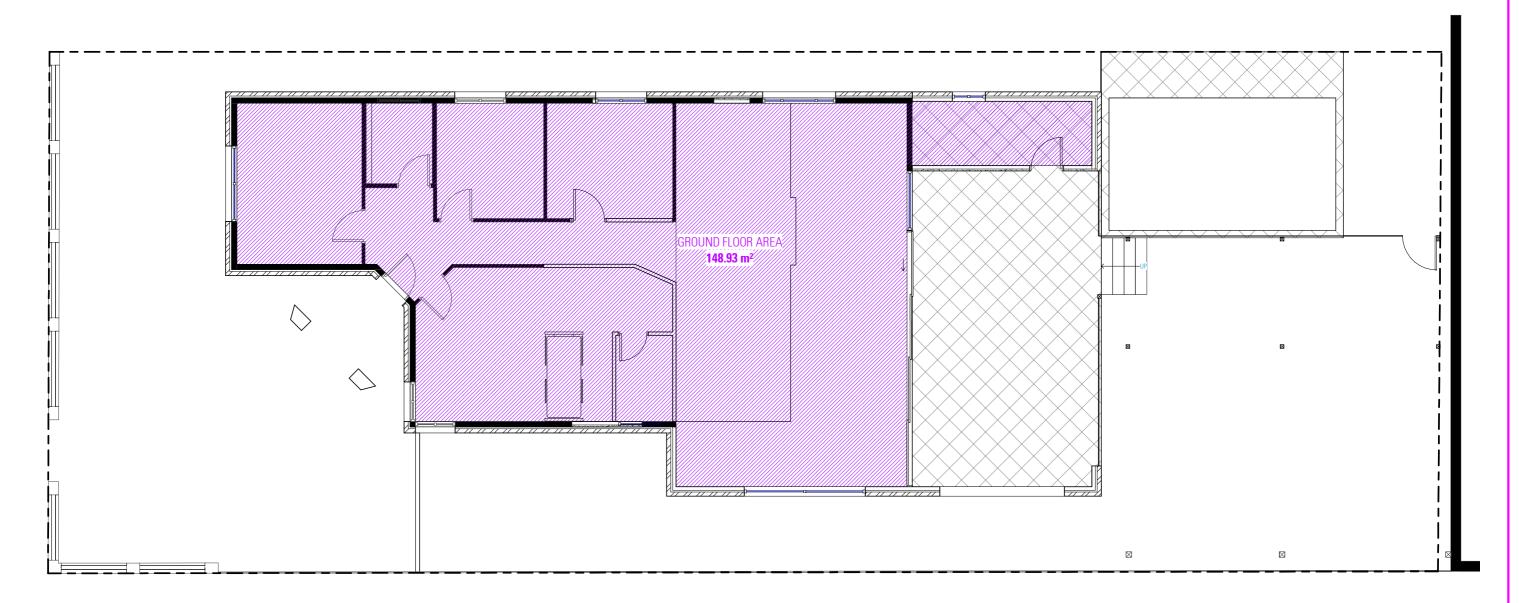

GROUND FLOOR GFA

NOT FOR CONSTRUCTION

NOTES

1. ALL DIMENSIONS ARE IN MILLIMETERS
2. VERIFY ALL DIMENSIONS ON SITE
3. DO NOT SCALE, USE FIGURED DIMENSIONS ONLY
4. VERIFY ALL DISCREPANCIES WITH THE DESIGNER
5. ALL WORKS TO COMPLY WITH THE NATIONAL
CONSTRUCTION CODE (B.C.A) & AUSTRALIAN STANDARDS

COPYRIGHT

THES DRAWINGS HAVE BEEN PREPARED BY ES DESIGN,
AND SHALL REMAIN THE PROPERTY OF THE SAME. NO
PORTION OF THESE DRAWINGS, WHETHER IN PART OR
WHOLE, SHALL BE USED IN ANY FORM, DUPLICATED OR
OTHERWISE, WITHOUT PRIOR WRITTEN PERMISSION OF
THE ARCHITECTY DESIGNER. THESE DRAWINGS ARE
SUBJECT TO COPYRIGHT LAWS.





ALTERATIONS AND ADDITIONS | DRAWING

62 CHELMSFORD AVENUE SHEET

BELMORE NSW 2192


GROSS FLOOR AREA CALCULATION


DESIGN BENITA ZEAITER DRAFTED JOSEPH YOUSSEF


VIVYAN SABA ISSUE A 20.05.24


SOLAR STUDY


[1 of 9] [June 21, 2010 - 08:00]

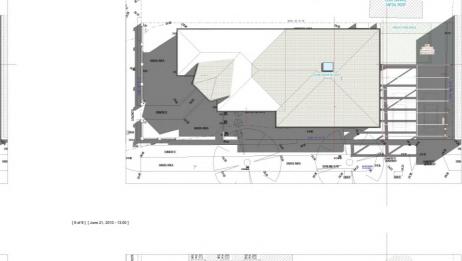


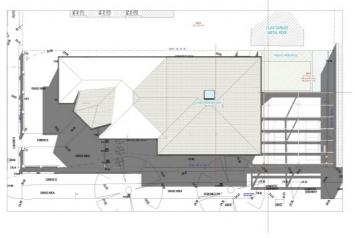

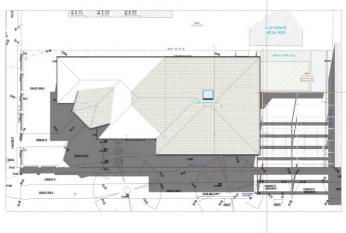

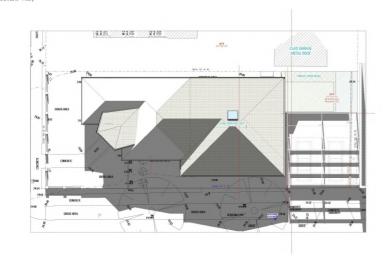

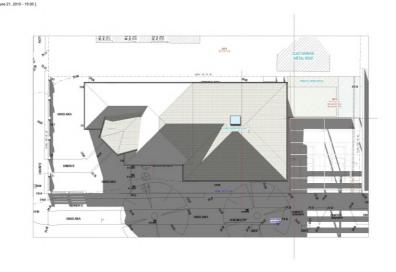

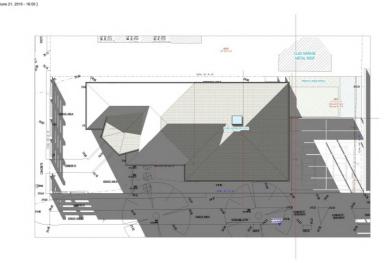

NOT FOR CONSTRUCTION

NOTES

1. ALL DIMENSIONS ARE IN MILLIMETERS
2. VERIFY ALL DIMENSIONS ON SITE
3. DO NOT SCALE, USE FIGURED DIMENSIONS ONLY
4. VERIFY ALL DISCREPANCES WITH THE DESIGNER
5. ALL WORKS TO COMPLY WITH THE NATIONAL
CONSTRUCTION CODE (B.C.A) & AUSTRALIAN STANDARDS

CONSTRUCTION CODE (B.C.A) & AUSTRALIAN STANDARDS

COPYRIGHT

THES DRAWINGS HAVE BEEN PREPARED BY ES DESIGN,
AND SHALL REMAIN THE PROPERTY OF THE SAME NO
PORTION OF THESE DRAWINGS, WHETHER IN PART OR
WHOLE, SHALL BE USED IN ANY FORM, DUPLICATED OR
OTHERWISE, WITHOUT PRIOR WRITTEN PERMISSION OF
THE ARCHITECT/ DESIGNER. THESE DRAWINGS ARE
SUBJECT TO COPYRIGHT LAWS.





ALTERATIONS AND ADDITIONS | DRAWING

DESIGN BENITA ZEAITER


DRAFTED JOSEPH YOUSSEF

62 CHELMSFORD AVENUE BELMORE NSW 2192

SOLAR STUDY

SCALE


DWG No. 24075 - 16 VIVYAN SABA ISSUE A 20.05.24

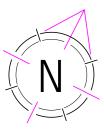

- REFER TO LANDSCAPE PLAN FOR DETAILS
- REFER TO STORMWATER PLAN FOR STORMWATER DETAILS

 TO / SEDIMENT AND EROSION CONTROL PLAN
- REFER TO STRUCTURAL PLAN FOR RETAINING WALL DETAILS DETAILS REFER TO STORMWATER PLAN AND BASIX REPORT FOR
- RAINWATER TANK DETAILS
- ALL BOUNDARY FENCING TO BE MAINTAINED OR CONSTRUCTED AT A HEIGHT OF 1800mm ABOVE NGL

	SITE C	ALCULATIONS		
ITEM		REQU	IIRED	PROPOSED
TOTAL SITE AREA (PARENT LOT)		>400.	00 sqm	506.4 sqm
PROPOSED GFA		278.52	2 sqm	148.93 sqm
DEEP SOIL AREA (SITE)	(MIN. 2.5m WIDE)	>20%	101.28 sqm	103.24 sqm (20.38%)
SITE COVERAGE		<50%	253.20 sqm	210.69 sqm (41.84%)
				•

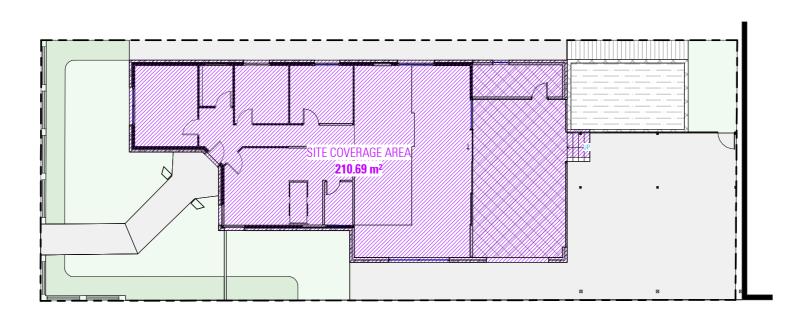

SITE COVERAGE PLAN

NOT FOR CONSTRUCTION

NOTES

1. ALL DIMENSIONS ARE IN MILLIMETERS
2. VERIFY ALL DIMENSIONS ON SITE
3. DO NOT SCALE, USE FIGURED DIMENSIONS ONLY
4. VERIFY ALL DISCREPANCIES WITH THE DESIGNER
5. ALL WORKS TO COMPLY WITH THE NATIONAL
CONSTRUCTION CODE (B.C.A) & AUSTRALIAN STANDARDS

COPYRIGHT

THES DRAWINGS HAVE BEEN PREPARED BY ES DESIGN,
AND SHALL REMAIN THE PROPERTY OF THE SAME. NO
PORTION OF THESE DRAWINGS, WHETHER IN PART OR
WHOLE, SHALL BE USED IN ANY FORM, DUPLICATED OR
OTHERWISE, WITHOUT PRIOR WRITTEN PERMISSION OF
THE ARCHITECTY DESIGNER. THESE DRAWINGS ARE
SUBJECT TO COPYRIGHT LAWS.





ALTERATIONS AND ADDITIONS | DRAWING

DRAFTED JOSEPH YOUSSEF

SITE COVERAGE

62 CHELMSFORD AVENUE BELMORE NSW 2192 DESIGN BENITA ZEAITER

VIVYAN SABA ISSUE A 20.05.24

BASIX COMMITMENTS

BASIX Certificate

Alterations and Additions



Project address	
Project name	62_che
Street address	62 CHELMSFORD AVENUE - BELMORE 2190
Local Government Area	Canterbury-Bankstown Council
Plan type and number	Deposited Plan 350140
Lot number	A
Section number	-
Project type	
Dwelling type	Dwelling house (detached)
Type of alteration and addition	The estimated development cost for my renovation work is \$50,000 or more, and includes a pool (and/or spa).
N/A	N/A

Pool and Spa	Show on DA Plans	Show on CCICDC Plans & specs	Certifier Check
Rainwater tank		,	
The applicant must install a rainwater tank of at least 1214.07 litres on the site. This rainwater tank must meet, and be installed in accordance with, the requirements of all applicable regulatory authorities.	~	~	~
The applicant must configure the rainwater tank to collect rainwater runoff from at least 50 square metres of roof area.		~	~
The applicant must connect the rainwater tank to a tap located within 10 metres of the edge of the pool.		~	~
Outdoor swimming pool			
The swimming pool must be outdoors.	~	~	~
The swimming pool must not have a capacity greater than 29 kilolitres.	-	~	~
The swimming pool must have a pool cover.		~	~
The applicant must install a pool pump timer for the swimming pool.		~	~
The applicant must install the following heating system for the swimming pool that is part of this development: electric heat pump.		~	~

			_
its	Show on DA Plans	Show on CC/CDC Plans & specs	Certifier Check
92			page

Glazing requirements	Show on DA Plans	Show on CC/CDC Plans & specs	Certifier Check
Windows and glazed doors			
The applicant must install the windows, glazed doors and shading devices, in accordance with the specifications listed in the table below. Relevant overshadowing specifications must be satisfied for each window and glazed door.	-	~	~
The following requirements must also be satisfied in relation to each window and glazed door:		~	~
Each window or glazed door with standard aluminium or timber frames and single clear or toned glass may either match the description, or, have a U-value and a Solar Intel Clean Coefficient (SHCC) no greater than that is		-	~
For projections described in millimetres, the leading edge of each eave, pergola, verandsh, balcony or awning must be no more than 500 mm above the head of the window or glazed door and no more than 2400 mm above the sill.	~	~	~
For projections described as a ratio, the ratio of the projection from the wall to the height above the window or glazed door sill must be at least that shown in the table below.	~	~	~
Pergolas with polycarbonate roof or similar translucent material must have a shading coefficient of less than 0.35.		~	~
Pergolas with fixed battens must have battens parallel to the window or glazed door above which they are situated, unless the pergola also shades a perpendicular window. The spacing between battens must not be more than 50 mm.		_	

Blazing requir							Show on DA Plans	Show on CC/CDC Plans & specs	Certifier Check
Windows and gla Windowldoor number	Zed doors glazing Orientation	Area of glass including frame (m2)	Overshadowing height (m)	Overshadowing distance (m)	Shading device	Frame and glass type			
W1	NW	1.35	0	0	projection/ height above sill ratio >=0.36	standard aluminium, single clear, (or U-value: 7.63, SHGC: 0.75)			
W2	NW	1.15	0	0	projection/ height above sill ratio >=0.36	standard aluminium, single clear, (or U-value: 7.63, SHGC: 0.75)			
W3	NW	0.75	0	0	projection/ height above sill ratio >=0.36	standard aluminium, single clear, (or U-value: 7.63, SHGC: 0.75)			
W4	NE	3.76	0	0	eave/ verandah/ pergola/balcony >=900 mm	standard aluminium, single clear, (or U-value: 7.63, SHGC: 0.75)			
WS	SE	3.84	0	0	eave/ verandah/ pergola/balcony >=450 mm	standard aluminium, single clear, (or U-value: 7.63, SHGC: 0.75)			

Slazing requir	ements						Show on DA Plans	Show on CC/CDC Plans & specs	Certifie Check
Windowldoor number	Orientation	Area of glass including frame (m2)	Overshadowing height (m)	Overshadowing distance (m)	Shading device	Frame and glass type			
W6	SE	0.72	0	0	eave/ verandah/ pergola/balcony >~450 mm	standard aluminium, single clear, (or U-value: 7.63, SHGC: 0.75)			
W7	SW	2.4	0	0	eave/ verandah/ pergola/balcony >=450 mm	standard aluminium, single clear, (or U-value: 7.63, SHGC: 0.75)			
SD1	NE	16.27	0	0	eave/ verandah/ pergola/balcony >=900 mm	standard aluminium, single clear, (or U-value: 7.63, SHGC: 0.75)			

DESIGN BENITA ZEAITER

DRAFTED JOSEPH YOUSSEF

NOT FOR CONSTRUCTION

NOTES

COPYRIGHT

ALL DIMENSIONS ARE IN MILLIMETERS

2. VERIFY ALL DIMENSIONS ON SITE

3. DO NOT SCALE, USE FIGURED DIMENSIONS ONLY

4. VERIFY ALL DISCREPANCIES WITH THE DESIGNER

5. ALL WORKS TO COMPLY WITH THE NATIONAL

CONSTRUCTION CODE (B.C.A) & AUSTRALIAN STANDARDS

CONSTRUCTION CODE (B.C.A) & AUSTRALIAN STANDARDS

COUNTRICTION CODE (B.C.A) & SAUSTRALIAN STANDARDS





ALTERATIONS AND ADDITIONS | DRAWING

BASIX COMMITMENTS 62 CHELMSFORD AVENUE

BELMORE NSW 2192 SCALE

DWG No. 24075 - 18 VIVYAN SABA ISSUE A 20.05.24